

6

Planning Commission Study Session

TO: PLANNING COMMISSION/DESIGN REVIEW BOARD

FROM: KEITH NEWMAN, PLANNER II

(480) 503-6812, KEITH.NEWMAN@GILBERTAZ.GOV

THROUGH: CATHERINE LORBEER AICP, PRINCIPAL PLANNER

(480) 503-6016, CATHERINE.LORBEER@GILBERTAZ.GOV

MEETING DATE: JUNE 6, 2018

SUBJECT: DR18-50 MOOG INDUSTRIAL BUILDING

STRATEGIC INITIATIVE: Economic Development

Encourage the protection and expansion of the land designated in the General Plan for Employment uses.

REQUEST

DR18-50, Moog Industrial Building: Site plan, landscaping, grading and drainage, elevations, floor plans, lighting, colors and materials for approximately 3.6 acres, generally located at the northeast corner of Guadalupe Road and Colorado Street, and zoned Light Industrial (LI) with a Planned Area Development (PAD) overlay.

RECOMMENDED MOTION

Request for input only. No motion required.

APPLICANT/OWNER

Company: Deutsch Architecture Group Company: Wentworth Property Co.

Name: Randy Hilleboe Name: David Dickson

Address: 4600 E. Indian School Rd. Address: 802 N. 3rd Avenue

Phoenix, AZ 85018 Phoenix, AZ 85003

Phone: 602-840-2929 Phone: 602-875-5025

Email: rhilleboe@2929.com Email: ddickson@wentprop.com

BACKGROUND/DISCUSSION

History

Date	Description
September 18, 1979	Town Council approved A80-02 (Ordinance No. 253), annexing
	approximately 360 acres, including the subject property.
September 3, 2002	Town Council approved Z02-11 (Ordinance No. 1416) creating the
	El Dorado Tech Center PAD.

Overview

The applicant is requesting to construct an office/warehouse building consisting of approx. 34,132 square feet. The proposed building will be constructed as phase one of an overall master site plan on 3.6 acres that will contain a future second phase on the far east side of the site with two (2) 4,800 square foot industrial buildings. The site is generally located at the northeast corner of Guadalupe Road and Colorado Street and zoned Light Industrial (LI) within the El Dorado Tech Center Planned Area Development.

Surrounding Land Use & Zoning Designations:

	Existing Land Use	Existing Zoning	Existing Use
	Classification		
North	Light Industrial (LI)	Light Industrial/PAD	Light Industrial (Walters and
		(LI)	Wolf)
South	Light Industrial (LI)	Light Industrial/PAD	Light Industrial (Rigid
		(LI)	Industries LED Lighting)
East	Light Industrial (LI)	Light Industrial/PAD	Light Industrial (Paragon
		(LI)	Vision Sciences)
West	Light Industrial (LI)	Light Industrial/PAD	Light Industrial (Maximus
		(LI)	Arizona Works)
Site	Light Industrial (LI)	Light Industrial/PAD	Vacant
		(LI)	

Project Data Table

Site Development Regulations	Required per LDC	Proposed
Maximum Building Height	55'	30'
Minimum Building Setbacks		
Front	30'	81'
Side to Street	20'	84'
Side to non-residential	0'	80'
Rear to non-residential	0'	41'
Minimum Required Perimeter		
Landscape Area		
Front	25'	25'
Side to Street	20'	25'
Side to non-residential	5'	5'
Rear to non-residential	5'	5'
Landscape (% of net lot area)	15%	28%

DISCUSSION:

Staff has recently completed the first review of the project and has provided comments to the applicant. Staff is supportive of the overall development and is bringing the project forward to Study Session to receive general Planning Commission/DRB input concerning the design of the site.

Site Plan:

The project as stated will consist of a 34,132 square foot office/warehouse building in phase one on the western portion of the property and two 4,800 square foot light industrial buildings in phase two to the east.

The overall site is currently vacant land and consists of three (3) parcels totaling 3.6 acres that will be reconfigured to accommodate the proposed phased development. The site is more specifically located on the northeast corner of Guadalupe Road and Colorado Street and will have one shared access point off of Guadalupe and a secondary access point off Colorado Street. The building has been situated in a manner that is generally centered with parking fields located on the north, south and east portions of the site. Public access will be drawn from both access points along the eastern and southern boundaries. A pedestrian walkway will be located along the southern and eastern boundaries and connect to the front entrance of the building. The site fencing includes an existing 8' high perimeter screen wall along the northern boundary and a 3' high parking screen wall located in front of the parking stalls along Guadalupe Road and Colorado Street. Currently no fencing is contemplated along the eastern property line, which faces an adjacent light industrial complex.

Based on the parking ratios of office/warehouse, 103 parking spaces are required in phase one and 132 spaces are provided. Phase two will require 16 spaces and 54 spaces are shown. Bicycle parking will be provided near the main entrance of the building at the southwest corner of the site. One large truck loading space on the site will be located at the rear of the building along the north elevation and will be 12' x 45' which meets Town standards.

An employee amenity area is depicted at the southeastern corner of the building. Please note that review comments have asked the project to further shield this area so it is only accessible to employees and that seating and additional shade be provided to further enhance this amenity for employee enjoyment.

Elevations:

For phase one, the proposed Moog Building will consist of single story structure with masonry construction highlighted by the use of glass and angled steel canopies and parapet roofing at the top of the building. The proposed color palette consists of "Earth" tone colors with light tan and two different shades of gray for the main building walls and a reddish clay color for the steel canopies. As the project moves forward and the phase two buildings are submitted for review, complementary design styles will be encouraged.

Landscaping:

The landscape plan proposes a varied palette of trees and shrubs. The tree types include: Mondel Pine, Swan Hill Olive, Evergreen Elm, Live Oak, and Cascalote. Some of the shrub and ground cover types include: Rio Bravo Sage, Baja Ruellia, Red Yucca, Desert Spoon, Red Bird of Paradise, Rosemary and Yellow Lantana. Foundation landscaping is currently proposed along the east, west and south elevations. Please note that review comments have asked the project to provide foundation landscaping along the north elevation.

Landscaping along the Guadalupe Street frontage, which contains existing turf, Mondel Pine Trees and Palm Trees, was installed with the previous road widening. A few additional trees and shrubs will be added by the developer within the Guadalupe Street frontage to fill in a few gaps and areas adjacent to the main entrance. The project will contain 28% landscape area.

Grading and Drainage:

On-site retention will be provided in underground and above ground retention basins within the landscape areas along the street frontage and within the parking lots. Town Engineering Staff is in the process of analyzing the proposed site grading and drainage to ensure compliance with Town standards.

Signage and Lighting:

Wall mounted light fixtures are attached to the building on the north and south elevations. Throughout the parking lot, 25 foot tall freestanding light poles are proposed to ensure sufficient site lighting and security.

Signage is not included in this approval. Administrative Design Review approval may be required prior to permitting.

PUBLIC NOTIFICATION AND INPUT

The proposed project will require public notice as specified under Land Development Code (LDC) Section 5.602.A.3.

REQUESTED INPUT

1. Overall building architecture and site design.

Respectfully submitted,

Keith Newman, Planner II

Attachments and Enclosures:

- 1) Vicinity/Aerial Map
- 2) Site Plan

- Landscape Plan
 Grading and Drainage Plan
 Building Elevations
 Floor Plan
 Lighting Photometric Plan
 Colors and Materials

DR18-50: Moog Industrial Building Attachment 1 - Vicinity/Aerial Map June 6, 2018

Map





DR18-50: Moog Industrial Building Attachment 2 - Site Plan June 6, 2018

12

9

13

ST

COLORADO

L-1 ZONING

GC ZONING

9

7

PARCEL

6

6

4

8

302-09-003K L-1 ZONING

-8

7


6

L-1 ZONING

9

4

GUADALUPE RD.

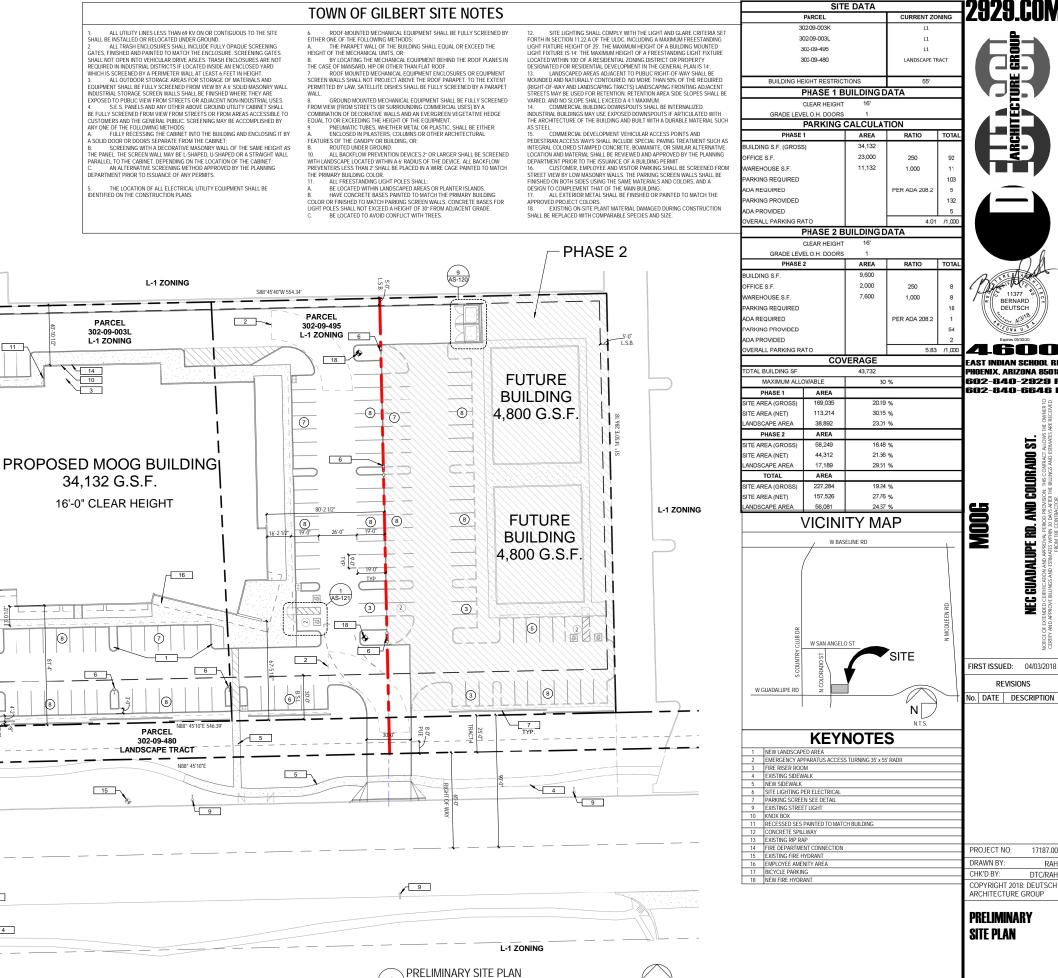

AS-110

17187.00













4600





EAST INDIAN SCHOOL REPHOENIX, ARIZONA 85018 602-840-2929 P 602-840-6646

900W


GUADALUPE RD, AND COLORADO ST. IFFOLIND ND APPRONE PROJECT ALONG THE CONTRACT ALLONG T

FIRST ISSUED: 04/02/18 Revisions

PROJECT NO:

DRAWN BY-CHK'D BY: COPYRIGHT 2018: DEUTSCH ARCHITECTURE GROUP

CONCEPTUAL **PLANTING PLAN**

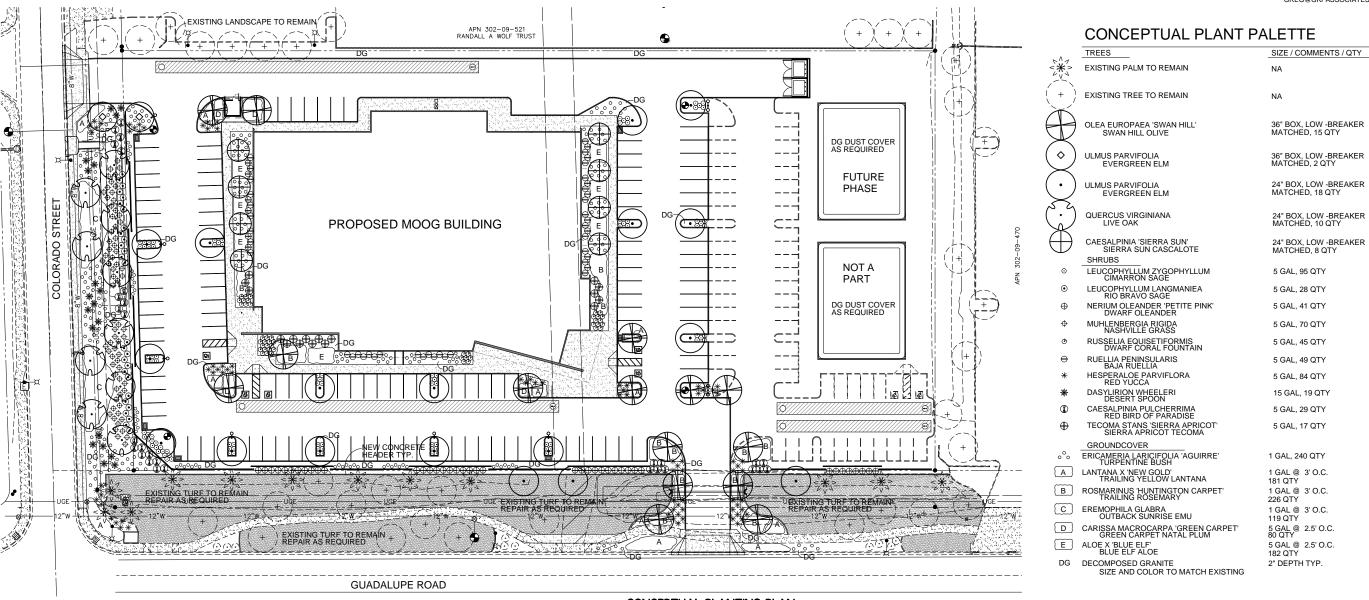

CONCEPTUAL PLANTING PLAN

- GENERAL NOTES
 ALL PLANTING AREAS TO HAVE TOP DRESSING OF DECOMPOSED GRANITE, SIZE & COLOR AS SPECIFIED EXISTING AT ADJACENT SITE TO THE WEST, 2" THICK, TYP. APPLIED OVER PRE-EMERGENT PER MFG. SPECS, 2 APPLICATIONS, MIN. VERIFY ALL CONDITIONS IN FIELD PRIOR TO BIDDING/ INSTALLATION.
- DISCREPANCIES SHALL BE BROUGHT TO THE LANDSCAPE ARCHITECT'S ATTENTION IN WRITING.
 NO PLANT SUBSTITUTION ALLOWED UNLESS APPROVED BY LANDSCAPE ARCHITECT AND
 TOWN OF GILBERT.
- LANDSCAPE ARCHITECT TO APPROVE ALL TREES AND SHRUBS PRIOR TO DELIVERY TO SITE LANDSCAPE ARCHITECT OR HIS REPRESENTATIVE RESERVE THE RIGHT
- LANDSCAPE ARCHITECT OR HIS REPRESENTATIVE RESERVE THE RIGHT TO REFUSE ANY PLANT HE/SHE DEEMS UNACCEPTABLE. FOR CLARIFICATION OF DISCREPANCIES BETWEEN THE DRAWINGS AND THE SITE, THEY SHOULD BE BROUGHT TO THE ATTENTION OF THE LANDSCAPE ARCHITECT PRIOR TO BEGINNING WORK. LANDSCAPE CONTRACTOR IS RESPONSIBLE TO TAKE PRECAUTIONS TO PROTECT ANY EXISTING IMPROVEMENTS. PLANT LIST/OTY'S PROVIDED FOR CONTRACTOR'S CONVENIENCE ONLY. DIAMS TAKE PRECEDENCE.
- PLANS TAKE PRECEDENCE.
 FINISHED GRADE BELOW ALL PLANTERS SHALL BE 1" BELOW ADJACENT
- HEADER, PAVING, CURBING, ETC.

 GROUNDCOVER AND/OR DG SHALL EXTEND UNDER SHRUBS UNLESS NOTED.
- ALL EARTHWORK IS TO BE DONE SO THAT ALL WATER DRAINS AWAY FROM ALL STRUCTURES.
 ALL UNDERGROUND CONDUITS/PIPES/UTLITIES ARE TO BE LOCATED PRIOR TO DIGGING.
 CONTRACTOR IS RESPONSIBLE FOR ALL REQUIRED SLEEVING WHETHER IT
- IS SHOWN ON THE PLANS OR NOT.

 ADJUST NEW LANDSCAPE TO ACCOMMODATE EXISTING LANDSCAPE TO REMAIN.
- LANDSCAPE CONTRACTOR RESPONSIBLE TO MAINTAIN EXISTING PLANT MATERIAL TO REMAIN IN GOOD, HEALTHY CONDITION DURING CONSTRUCTION.

TOWN OF GILBERT NOTES:

- A Town of Gilbert permit is required for the installation of any landscape or irrigation system. Irrigation lines must be inspected before backfilling. A CD with PDF format "AS-BUILTS" of the landscape & irrigation plans are also required.
- "Before the Town of Gilbert will accept and installed backflow device for approval the following must be accomplished: The device must be tested by a State Certified Backflow Tester and the test results forwarded to the Town of Gilbert Backflow Specialist. The Town will provide an up-to-date list of Certified Testers from which to be selected. Tester fees will be at the expense of the Installer."
- Design of walls, entry monument sign, and ramadas as presented herein have been reviewed as conceptual only and will require a separate review and permit from the Building Department. In no case shall the depicted walls, entry monument signs, and ramadas be considered final. Approval by the Planning Department is required prior to the issuance of a Building Permit for said walls, entry monuments, and ramadas.
- No plant material shall come within 3 feet of fire hydrants and Fire Department
- No objects within the Town of Gilbert sight triangles shall exceed 2 feet, and trees shall have a 7 feet minimum clear canopy. All trees, shrubs, and groundcovers are to meet or exceed A.N.A. specifications.
- Construction may begin after all permits have been obtained.

ALL LANDSCAPING SHALL COMPLY WITH TOWN OF GILBERT STANDARD DETAIL GIL-212 AT TIME OF INSTALLATION. ALL TREES WITHIN THE SIGHT LINE SHALL CANOPY AT 7' WHEN INSTALLED AND NO VEGETATION OR HARDSCAPE THAT WILL BE ABOVE 24" (AT MATURITY) WILL BE ALLOWED WITHIN THE SIGHT LINE

CONSTRUCTION AND INSTALLATION SHALL BE IN ACCORDANCE WITH THESE PLANS AND ANY AND ALL DEVIATIONS WILL REQUIRE REAPPROVAL. LANDSCAPE INSTALLATIONS TO BE APPROVED BY THE TOWN OF GILBERT INSPECTION SERVICES BEFORE CERTIFICATE OF OCCUPANCY IS ISSUED.

MAINTENANCE NOTE

All landscape areas and materials shall be maintained in a healthy, neat, clean, and weed-

This shall be the responsibility of the PROPERTY OWNERS

LANDOCADE CITE DATA

LANDSCAPE SHE DATA	_	
TOTAL NET SITE AREA	203,975 SQ. FT.	_4.7 AC.
SQUARE FOOTAGE OF ON-SITE LANDSCAPING	_42,909 SQ. FT.	_21 % OF SITE
SQUARE FOOTAGE OF PUBLIC RIGHT-OF-WAY LANDSCAPING	15,023 SQ. FT.	_7 % OF SITE
SQUARE FOOTAGE OF ON-SITE & ROW LANDSCAPING	_57,932 SQ. FT.	



SIZE / COMMENTS / QTY

36" BOX, LOW -BREAKER MATCHED, 15 QTY

36" BOX, LOW -BREAKER MATCHED, 2 QTY

24" BOX, LOW -BREAKER MATCHED, 18 QTY

24" BOX, LOW -BREAKER MATCHED, 10 QTY

24" BOX, LOW-BREAKER MATCHED, 8 QTY

5 GAL, 95 QTY

5 GAL, 28 QTY

5 GAL, 41 QTY

5 GAL, 70 QTY

5 GAL, 45 QTY

5 GAL, 49 QTY

5 GAL, 84 QTY

15 GAL, 19 QTY 5 GAL, 29 QTY

5 GAL, 17 QTY

1 GAL, 240 QTY

1 GAL @ 3' O.C. 181 QTY 1 GAL @ 3' O.C. 226 QTY

1 GAL @ 3' O.C. 119 QTY

5 GAL @ 2.5' O.C. 80 QTY

5 GAL @ 2.5' O.C. 182 QTY

2" DEPTH TYP.

NA

NA

CONCEPTUAL PLANT PALETTE

TREES

 \Diamond

EXISTING PALM TO REMAIN

EXISTING TREE TO REMAIN

OLEA EUROPAEA 'SWAN HILL' SWAN HILL OLIVE

ULMUS PARVIFOLIA EVERGREEN ELM

ULMUS PARVIFOLIA EVERGREEN ELM

QUERCUS VIRGINIANA LIVE OAK

SHRUBS

CAESALPINIA 'SIERRA SUN' SIERRA SUN CASCALOTE

LEUCOPHYLLUM ZYGOPHYLLUM CIMARRON SAGE

HESPERALOE PARVIFLORA RED YUCCA

CAESALPINIA PULCHERRIMA RED BIRD OF PARADISE

DASYLIRION WHEELERI DESERT SPOON







4600 EAST INDIAN SCHOOL RD PHOENIX, ARIZONA 85018 602-840-2929 P 602-840-6646

M00G

NEC GUADALUPE RD, AND COLORADO ST. MOD GERITATION NO PRESON PRODUCED IN SOME TAURE IN THE OFFICE THAN TO THE PROPURE BLUNGS ARE EXCELLED FROM


FIRST ISSUED: 04/02/18 Revisions

PROJECT NO:


DRAWN BY: COPYRIGHT 2018: DEUTSCH ARCHITECTURE GROUP

COLOR RENDERED LANDSCAPE PLAN


L-000

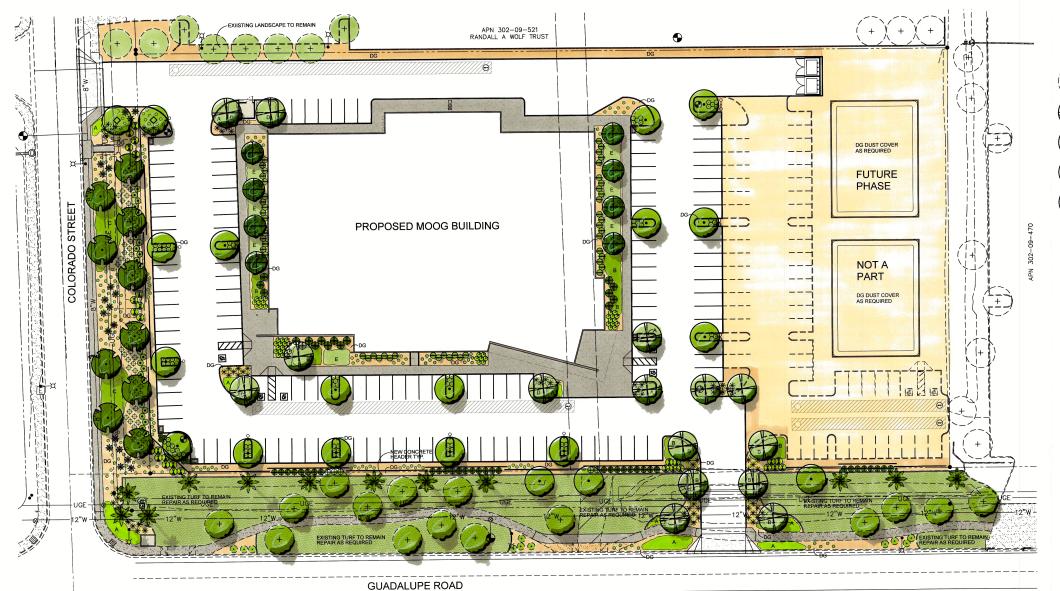

COLOR RENDERED LANDSCAPE PLAN

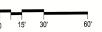

ERICAMERIA LARICIFOLIA 'AGUIRRE TURPENTINE BUSH A LANTANA X 'NEW GOLD' TRAILING YELLOW LANTANA B ROSMARINUS 'HUNTINGTON CARPET'
TRAILING ROSEMARY C EREMOPHILA GLABRA OUTBACK SUNRISE EMU D CARISSA MACROCARPA 'GREEN CARPET'
GREEN CARPET NATAL PLUM E ALOE X 'BLUE ELF' BLUE ELF ALOE DG DECOMPOSED GRANITE SIZE AND COLOR TO MATCH EXISTING

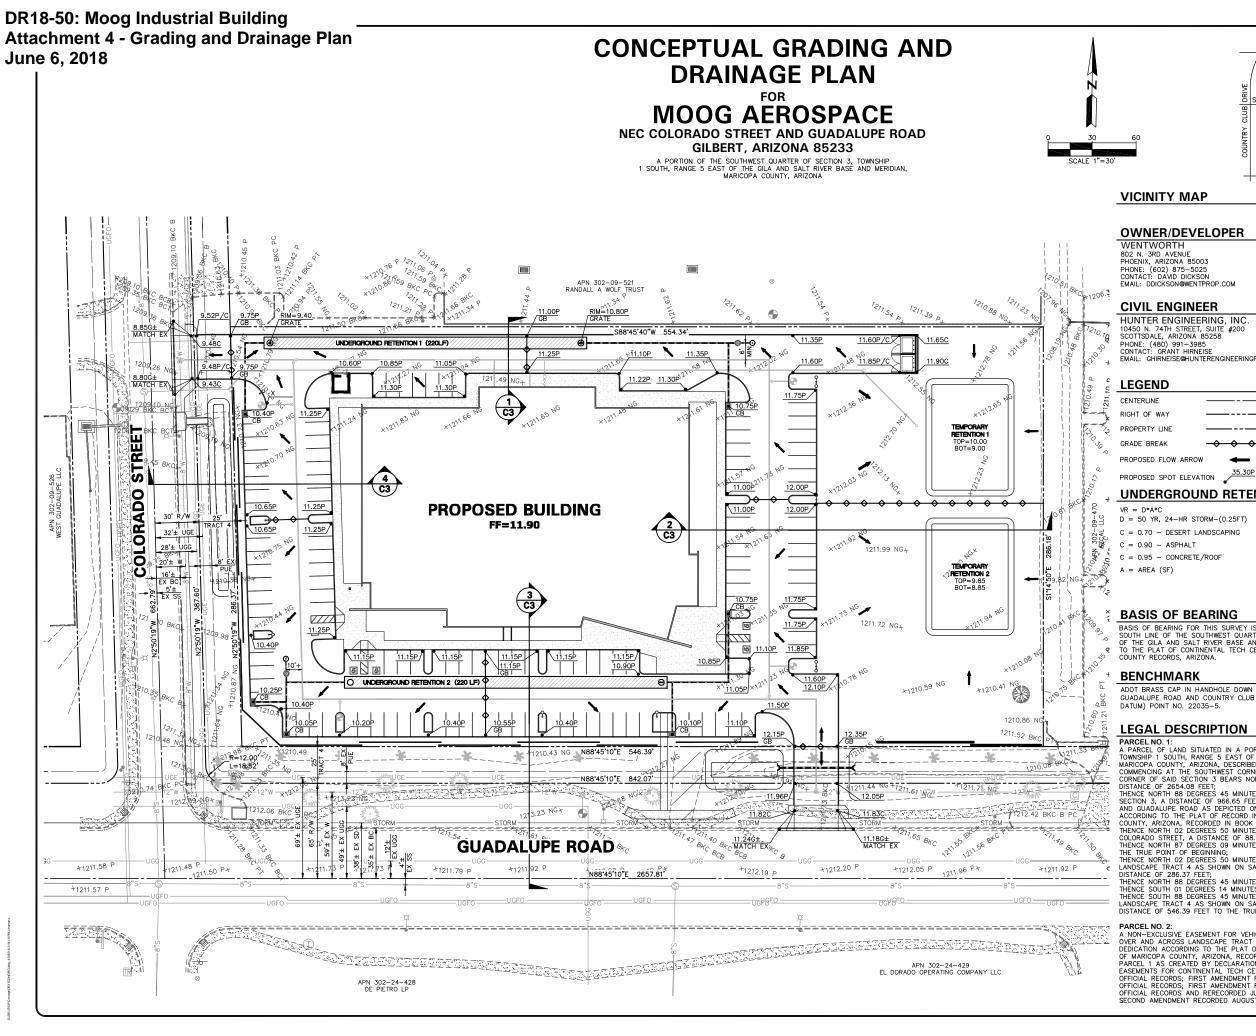




4600 E. INDIAN SCHOOL ROAD PHOENIX, ARIZONA 85018

HUNTER ENGINEERING, INC. 10450 N. 74TH STREET, SUITE #200 SCOTTSDALE, ARIZONA 85258

*NOTE: WEIGHTED C-VALUE USED FOR DRAINAGE AREAS

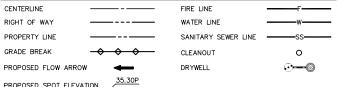

UNDERGROUND RETENTION

VR = D*A*C	UNDERGROUND 1	TEMPORARY 1
D = 50 YR, 24-HR STORM-(0.25FT)	A = 53,036 SF	A = 16,438 SF
C = 0.70 - DESERT LANDSCAPING	VR = (0.25)(53,036)(C*)	VR = (0.25)(16,438)(C*)
C = 0.90 - ASPHALT	VR = 11,953 CU.FT	VR = 2,877 CU.FT
C = 0.95 - CONCRETE/ROOF	UNDERGROUND 2	TEMPORARY 2
A = AREA (SF)	A = 62,994 SF	A = 25,064 SF
	VR = (0.25)(62,994)(C*)	VR = (0.25)(25,064)(C*
	VR = 14,135 CU.FT	VR = 4,386 CU.FT

BASIS OF BEARING

BASIS OF BEARING FOR THIS SURVEY IS A BEARING OF NORTH 88'45'10" EAST, ALONG THE SOUTH LINE OF THE SOUTHWEST QUARTER OF SECTION 3, TOWNSHIP 1 SOUTH, RANGE 5 EAST OF THE GILA AND SALT RIVER BASE AND MERIDIAN, MARICOPA COUNTY, ARIZONA, ACCORDING TO THE PLAT OF CONTINENTAL TECH CENTER, RECORDED IN BOOK 308, PAGE 17, MARICOPA

ADOT BRASS CAP IN HANDHOLE DOWN 0.5' NO STAMPINGS AT THE INTERSECTION OF GUADALUPE ROAD AND COUNTRY CLUB (STATE ROUTE 87). ELEVATION= 1210.457 (NAD83

PARCEL NO. 1:

A PARCEL OF LAND SITUATED IN A PORTION OF THE SOUTHWEST QUARTER OF SECTION 3, TOWNSHIP 1 SOUTH, RANGE 5 EAST OF THE GILA AND SALT RIVER BASE AND MERIDIAN, MARICOPA COUNTY, ARIZONA, DESCRIBED AS FOLLOWS:

COMMENCING AT THE SOUTHWEST CORNER OF SAID SECTION 3 FROM WHICH THE WEST QUARTER CORNER OF SAID SECTION 3 BEARS NORTH 02 DEGREES 53 MINUTES 38 SECONDS WEST, A DISTANCE OF 2654 OR FEFT.

CORNER OF SAID SECTION 3 BEARS NORTH 02 DEGREES 53 MINUTES 38 SECONDS WEST, A DISTANCE OF 2654.08 FEET;
THENCE NORTH 88 DEGREES 45 MINUTES 10 SECONDS EAST, ALONG THE SOUTH LINE OF SAID SECTION 3, A DISTANCE OF 966.65 FEET TO A POINT OF INTERSECTION OF COLORADO STREET AND GUADALUPE ROAD AS DEPICTED ON THE CONTINENTAL TECH CENTER MAP OF DEDICATION, ACCORDING TO THE PLAT OF RECORD IN THE OFFICE OF THE COUNTY RECORDER OF MARICOPA COUNTY, ARIZONA, RECORDED IN BOOK 308 OF MAPS, PAGE 17;
THENCE NORTH 02 DEGREES 50 MINUTES 21 SECONDS EAST, ALONG THE CENTERLINE OF SAID COLORADO STREET, A DISTANCE OF 88.51 FEET;
THENCE NORTH 87 DEGREES 09 MINUTES 39 SECONDS EAST, A DISTANCE OF 55.00 FEET TO THE TELLY POINT OF REGINNING:

THENCE NORTH 87 DEGREES 09 MINUTES 39 SECONDS EAST, A DISTANCE OF 55.00 FEET TO THE TRUE POINT OF BEGINNING;
THENCE NORTH 02 DEGREES 50 MINUTES 21 SECONDS WEST, ALONG THE EASTERLY LINE OF LANDSCAPE TRACT 4 AS SHOWN ON SAID CONTINENTAL TECH CENTER MAP OF DEDICATION, A DISTANCE OF 286.37 FEET;
THENCE NORTH 88 DEGREES 45 MINUTES 42 SECONDS EAST, A DISTANCE OF 554.35 FEET;
THENCE SOUTH 01 DEGREES 14 MINUTES 50 SECONDS EAST, A DISTANCE OF 286.18 FEET;
THENCE SOUTH 88 DEGREES 45 MINUTES 10 SECONDS WEST, ALONG THE NORTHERLY LINE OF LANDSCAPE TRACT 4 AS SHOWN ON SAID CONTINENTAL TECH CENTER MAP OF DEDICATION, A DISTANCE OF 546.39 FEET TO THE TRUE POINT OF BEGINNING.

PARCEL NO. 2:

A NON-EXCLUSIVE EASEMENT FOR VEHICULAR AND PEDESTRIAN INGRESS AND EGRESS IN, UPON, OVER AND ACROSS LANDSCAPE TRACT 4 AS DEPICTED ON CONTINENTAL TECH CENTER MAP OF DEDICATION ACCORDING TO THE PLAT OF RECORD IN THE OFFICE OF THE COUNTY RECORDER OF MARICOPA COUNTY, ARIZONA, RECORDED IN BOOK 308 OF MAPS, PAGE 17, ADJACENT TO PARCEL 1 AS CREATED BY DECLARATION OF COVENANTS, CONDITIONS, RESTRICTIONS AND EASEMENTS FOR CONTINENTAL TECH CENTER RECORDED AUGUST 8, 1986 IN 88-494774, OF OFFICIAL RECORDS; FIRST AMENDMENT RECORDED OCTOBER 06, 1988 IN 88-494774, OF OFFICIAL RECORDS, FIRST AMENDMENT RE-RECORDED OCTOBER 19, 1988 IN 88-516441, OF OFFICIAL RECORDS AND RERECORDED JULY 10, 1989 IN 89-312262, OF OFFICIAL RECORDS, SECOND AMENDMENT RECORDED AUGUST 7, 1996 IN 96-0558863, OF OFFICIAL RECORDS.

ARCHITECT

DEUTSCH ARCHITECTURE GROUP PHONE: (602) 840-2929 CONTACT: RANDY HILLEBOE EMAIL: RHILLEBOE ©2929.COM

TOTAL ACREAGE

NET	3.62 AC
GROSS	5.22 AC

PRELIMINARY PLANS

HUNTERENGINEERING

NOT FOR CONSTRUCTION

74TH S SUIT E, AZ 8, 0 991 3

B ALUPE DRAINAGE UAL GRADING AND DRAINA FOR MOOG AEROSPACE ORADO ST AND GUADA ILBERT, ARIZONA 85233 CONCEPTUAL COLOF

EC ONIACI ARZONA SII AI LEASI 2 FUL WORKING DAYS BETORE YOU BEON EXCAVATIO AR ZONAS 1.1 CALL SII OF CUCK ARZONASII.COM

THESE PLANS ARE NOT APPROVED FOR CONSTRUCTION
WITHOUT AN
APPROVED SIGNATURE
FROM THE GOVERNING
MUNICIPALITY.

PROJECT NAME: MOOG AEROSPACE

HE NO.: DEUTO37 SCALE:1" = 30'

SHEET:



|2929.COM| EXTERIOR MATERIAL LEGEND

8x16", SMOOTH FACE CMU, PAINTED DUNN EDWARDS "FORMAL GRAY"

8x8x16", SMOOTH FACE, VERTICAL SCORED CMU, PAINTED DUNN EDWARDS "NOMADIC TAUPE" DE6192

PAINT - DUNN EDWARDS "PRAIRIE CLAY" DET450

EAST INDIAN SCHOOL RD PHOENIX, ARIZONA 85018 602-840-2929 P 602-840-6646 F

FIRST ISSUED: 04/03/2018


REVISIONS No. DATE DESCRIPTION


PROJECT NO:

DRAWN BY: RAH/JM CHK'D BY: COPYRIGHT 2018: DEUTSCH ARCHITECTURE GROUP

PRELIMINARY WEST ENTRY PERSPECTIVE

A-210

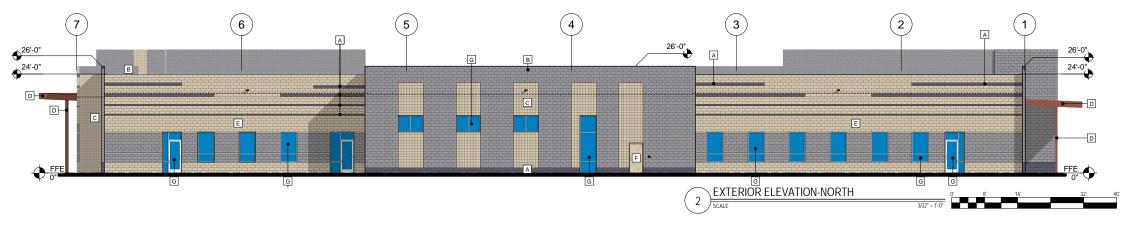

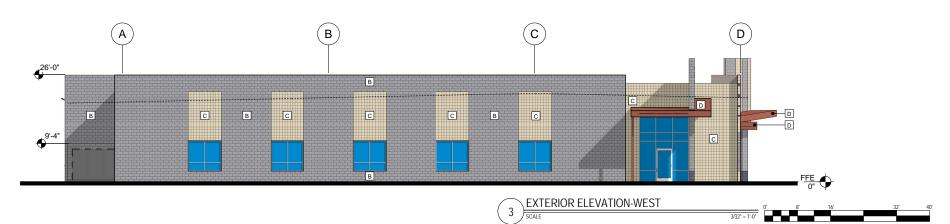



EXTERIOR MATERIAL LEGEND

A 8x8x16*, SPLIT FACE CMU, PAINTED DUNN EDWARDS "IRON FIXTURE" DE6384

8x8x16*, SMOOTH FACE CMU, PAINTED DUNN EDWARDS "FORMAL GRAY" DE6382

8x8x16", SMOOTH FACE, VERTICAL SCORED CMU, PAINTED DUNN EDWARDS "NOMADIC TAUPE" DE6192

PAINT - DUNN EDWARDS "PRAIRIE CLAY" DET450

E 8x8x16", SMOOTH FACE CMU, PAINTED DUNN EDWARDS "NOMADIC TAUPE" DE6192

PAINT- DUNN EDWARDS "NOMADIC TAUPE" DE6192

CLEAR ANODIZED ALUMINUM FRAME WITH SOLARBAN 60 SOLARGRAY & CLEAR GLASS INSULATED GLAZING

BERNARD BEUSCH

4-6000 EAST INDIAN SCHOOL RD PHOENIX, ARIZONA 85018 602-840-2929 P 602-840-6646 F

-2929 P -29246 F ESIMAZIES ARE RECEIVED

IEFT Annbeec

PROJECT
DED CERTIFICATION AND APPROVAL PROVE BILLINGS AND ESTIMATES WITHIN
FROW THE FROM THE

FIRST ISSUED: 04/03/2018

REVISIONS

No. DATE DESCRIPTION

 PROJECT NO:
 17187.00


 DRAWN BY:
 RAH/JM

 CHK'D BY:
 DTC/RAH

PRELIMINARY
EAST ENTRY
PERSPECTIVE

A-211

1 PRELIMINARY ENTRY PERSPECTIVE

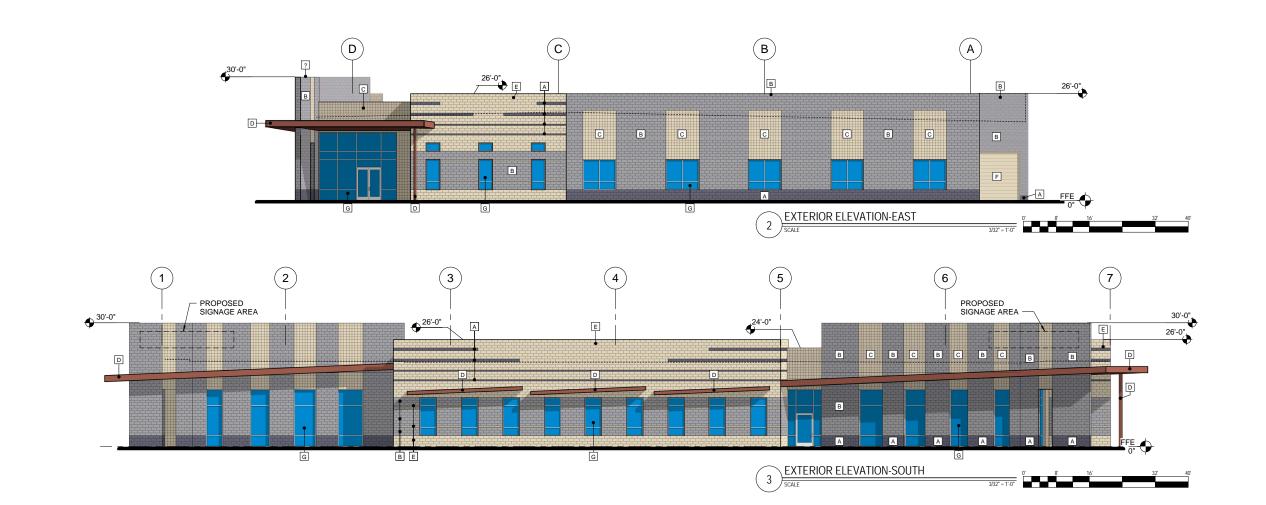



DR18-50: Moog Industrial Building Attachment 6 - Floor Plan June 6, 2018


80'-0" 2.8' 6.0' 8.0' 4.0' 6.0' 4.0' 6.0' 4.0' 4.0' 4.8' 48 40 40 28 34 40 60 40 60 40 60 40 60 B SHELL BUILDING 34,132 G.S.F. (c) D 88 40 64 40 60 40 60 40 60 40 60 40 60 40 60 40 60 40 60 40 60 PRELIMINARY FLOOR PLAN - SHELL




DR18-50: Moog Industrial Building Attachment 7 - Lighting Photometric Plan June 6, 2018

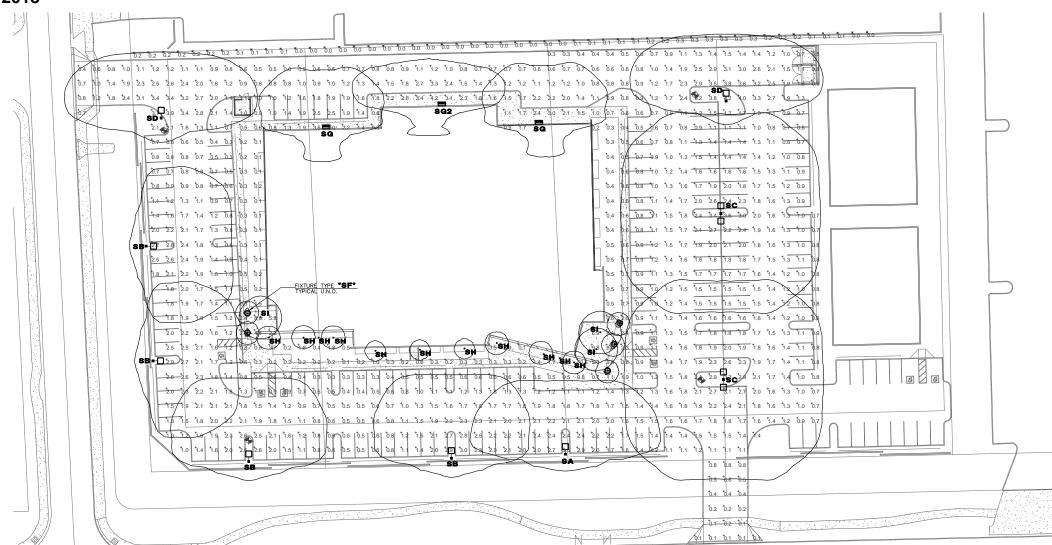

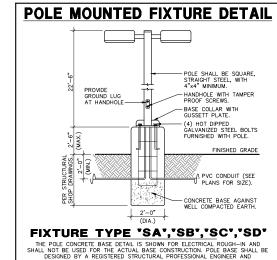

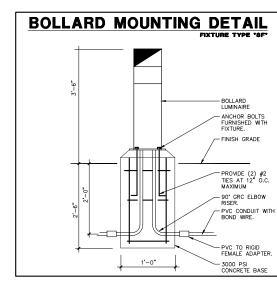

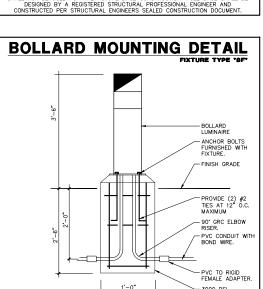





4600 EAST INDIAN SCHOOL RD PHOENIX, ARIZONA 85018 602-840-2929 F 602-840-6646₉ F

MOOG AEROSPACE

FIRST ISSUED

REVISIONS

DRAWN BY:DH COPYRIGHT 2018: DEUTSCH ARCHITECTURE GROUP

PROJECT NO: 18081

ELECTRICAL **PHOTOMETRIC**

PIAN



Statistics						
Description	Symbol	Avg	Max	Min	Max/Min	Avg/Min
PROP LINE NORTH - FC @ 5' AFG	ж	0.1 fc	0.3 fc	0.0 fc	N/A	N/A
SITE - FC @ GRADE	+	1.4 fc	10.6	0.1 fc	106.0:1	14.0:1

ımp										
Symbol	Label	Quantity	Manufacturer	Catalog Number	Description	Lamp	Filename	Lumens Per Lamp	Light Loss Factor	Wattage
	SA	1	Lithonia Lighting	DSX1 LED P4 40K T3M MVOLT HS (FINISH) / SSS 22.5' W/2.5' BASE	DSX1 LED P4 40K T3M MVOLT with houseside shield	LED	DSX1_LED_P4_40K_T3M_MV OLT_HS.ies	11404	0.91	125
•	SB	4	Lithonia Lighting	DSX1 LED P4 40K T4M MVOLT HS (FINISH) / SSS 22.5' W/2.5' BASE	DSX1 LED P4 40K T4M MVOLT with houseside shield	LED	DSX1_LED_P4_40K_T4M_MV OLT_HS.ies	11006	0.91	125
][sc	2	Lithonia Lighting	(2) DSX1 LED P4 40K T5W MVOLT (FINISH) / SSS 22.5' W/2.5' BASE	TWIN-HEAD DSX1 LED P4 40K T5W MVOLT	LED	DSX1_LED_P4_40K_T5W_MV OLT.ies	14943	0.91	250
0	SD	2	Lithonia Lighting	DSX1 LED P4 40K T2S MVOLT (FINISH) / SSS 22.5' W/2.5' BASE	DSX1 LED P4 40K T2S MVOLT	LED	DSX1_LED_P4_40K_T2S_MVO LT.ies	14532	0.91	125
0	SF	5	VISIONAIRE LIGHTING	EDS-1A COG 20 3 40K UNV AB BK ILS MD	11" SQ. X 41" LED LUMINAIRE 20 LED PLATE, WITH 350MA SETTING.	LED	eds-1A- HZG_T5_20L_3_55K.IES	271	0.91	20
	SG	2	Lithonia Lighting	DSXW1 LED 20C 1000 40K T4M MVOLT ELCW (FINISH)	DSXW1 LED WITH (2) 10 LED LIGHT ENGINES, TYPE T4M OPTIC, 4000K, @ 1000mA. EMERGENCY BATTERY BACKUP	LED	DSXW1_LED_20C_1000_40K_ T4M_MVOLT.ies	7420	0.91	73.2
	SG2	1	Lithonia Lighting	DSXW1 LED 20C 1000 40K T2M MVOLT ELCW (FINISH)	DSXW1 LED WITH (2) 10 LED LIGHT ENGINES, TYPE T2M OPTIC, 4000K, @ 1000mA. EMERGENCY BATTERY BACKUP	LED	DSXW1_LED_20C_1000_40K_ T2M_MVOLT.ies	7373	0.91	73.2
\bigcirc	SH	9	Gotham Architectural Lighting	ICO CYL 40/10 4AR LSS 20D CRI80	ICO CYL 4000K 1000 LUMENS 20 DEGREE BEAM	LED	ICO_CYL_40_10_4AR_LD_20 D_CRI80.ies	1160	0.91	11.1256
\bigcirc	SI	3	Gotham Architectural Lighting	EVO CYL 40/20 8AR MWD LSS EZ10	8" EVO 4000K 80 CRI 2000LM	LED	EVO_CYL_30_20_8AR_MWD_ LS.ies	2287	0.91	31.55



